



COPE AND WELD DETAIL

SCALE: $1^{1}/2^{"} = 1^{'} - 0^{"}$

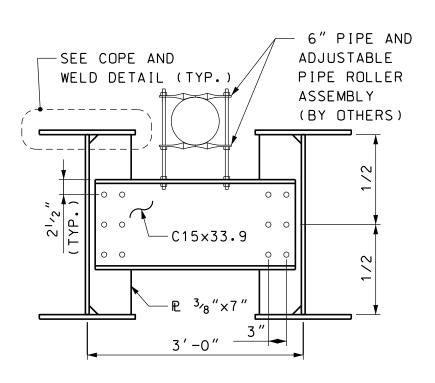

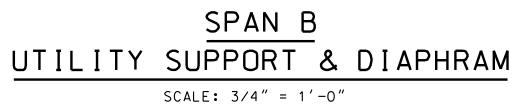


SUPERSTRUCTURE NOTES

- 1. ALL STRUCTURAL STEEL SHALL MEET THE REQUIREMENTS OF ITEM 550.108, STRUCTURAL STEEL (F), INCLUDING THE GIRDERS, CROSS FRAMES, DIAPHRAGMS, GUSSET PLATES, FILL PLATES, CONNECTION PLATES, SPLICE PLATES, STIFFENERS, AND FASTENERS.
- 2. NOTCH TOUGHNESS REQUIREMENTS OF NHDOT STANDARD SPECIFICATIONS SHALL APPLY TO THE WEB AND FLANGES OF GIRDERS AND SPLICE PLATES.
- 3. ALL BOLTED CONNECTIONS SHALL BE SLIP-CRITICAL (CLASS-B) MADE WITH $\frac{7}{6}$ " ϕ high strength BOLTS IN ${}^{15}\!\!/_{16}{}''$ ϕ holes. All fasteners shall conform to requirements for AASHTO M164 (ASTM A325) TYPE 3.
- 4. ALL BOLTS IN FIELD SPLICE SHALL HAVE THREADS EXCLUDED FROM THE THICK FLANGES.
- 5. DIRECT TENSION INDICATOR WASHERS SHALL BE INSTALLED WITH HIGH STRENGTH BOLTS.
- 6. GIRDERS SHALL BE CAMBERED FOR FULL DEAD LOAD DEFLECTION EQUAL TO: SPANS A & C = $\frac{1}{2}$ AT MIDSPAN SPAN B = 21 $\frac{1}{2}$ at midspan
- 7. BEARING STIFFENERS AND ENDS OF THE GIRDERS SHALL BE VERTICAL UNDER FULL DEAD LOAD DEFLECTION.
- 8. ALL WELDS SHALL HAVE CORROSION RESISTANCE AND WEATHERING APPEARANCE AS SPECIFIED FOR WEATHERING STRUCTURAL STEEL.
- 9. THE STRUCTURAL STEEL FABRICATOR SHALL ARRANGE FOR NON-DESTRUCTIVE TESTING OF THE WELDS.
- 10. SHOP DRAWINGS SHALL INDICATE THE METHOD AND SEQUENCE TO BE FOLLOWED IN WELDING THE GIRDER COMPONENTS.
- 11. LOCATION OF WELDED SHOP SPLICES SHALL BE: WEB SPLICES SHALL BE LOCATED A MINIMUM OF 9" FROM WELDED FLANGE SPLICES. WEB AND FLANGE SPLICES SHALL BE LOCATED A MINIMUM OF 6" FROM TRANSVERSE STIFFENERS OR CONNECTION PLATES.
- 12. ANY SHOP OR FIELD WELDING OF ATTACHMENTS TO ANY PORTION OF THE PLATE GIRDERS FOR CONSTRUCTION PURPOSES WILL NOT BE PERMITTED, UNLESS APPROVED BY THE ENGINEER.
- 13. THE CONTRACTOR SHALL SUBMIT A HANDLING AND ERECTION PROCEDURE TO THE ENGINEER PRIOR TO HANDLING THE STRUCTURAL STEEL IN ACCORDANCE WITH SECTION 550.3.14 AND 550.3.15. THE ERECTION PROCEDURE SHALL INDICATE THE LOCATION AND NUMBER OF LIFTING POINTS AS DETERMINED BY CHECKING THE L/B RATIOS IN ACCORDANCE WITH SECTION 550.3.14.2.4 TO GUARD AGAINST LATERAL BUCKLING OF THE GIRDERS.
- 14. STEEL ERECTION SHALL NOT BE PERMITTED UNTIL THE PIERS HAVE BEEN BACKFILLED TO THE LEVEL OF THE EXISTING GROUND SHOWN IN THESE PLANS.
- 15. ALL WELDING AND FABRICATION SHALL BE PREFORMED IN CONFORMANCE WITH THE AASHTO/AWS D1.5-08 BRIDGE WELDING CODE, (INCLUDING ALL REVISIONS PUBLISHED BY AASHTO AS OF THE BID OPENING DATE) AND THE NHDOT STANDARD SPECIFICATIONS FOR ROAD AND BRIDGE CONSTRUCTION.
- 16. THE CABLE OR CHAIN, TENSION DEVICE, AND ALL ATTACHMENTS USED IN THE GIRDER BRACING SYSTEM, SHALL BE CAPABLE OF WITHSTANDING A 8-KIP TENSILE LOAD.
- 17. THE CABLE OR CHAIN USED IN THE FLANGE SUPPORT SYSTEM SHALL HAVE APPROXIMATELY 2% SLACK UNDER THE NO-WIND CONDTION. THE CABLE OR CHAIN SHALL NOT BE TENSIONED SUCH THAT A DOWNWARD FORCE IS IMPOSED ON THE BEAM UNDER THE NO-WIND CONDITION.
- 18. THE FOLLOWING VERTICAL DEFLECTIONS DUE TO THE DESIGN PIPE LOAD AND ICE LOAD ARE ANTICIPATED ON THE GAS LINE: SPANS A & C = $\frac{1}{8}$ AT MIDSPAN SPAN B = $3 \frac{3}{4}$ at midspan
- 19. THE FOLLOWING HORIZONTAL DEFLECTIONS DUE TO THE DESIGN WIND LOAD ARE ANTICIPATED ON THE GAS LINE: SPANS A & C = 1.5/8'' AT MIDSPAN

SPAN B = 27/8'' AT MIDSPAN


20. HOLES IN THE SPAN A AND SPAN C GIRDER TOP FLANGES, AND THE SPAN B DIAPHRAGM TOP FLANGES, FOR THE THREADED RODS FOR THE PIPE ROLLERS SHALL BE SHOP DRILLED. CONTRACTOR SHALL COORDINATE FINAL LAYOUT AND SIZE OF THESE HOLES WITH UNITIL. THE HOLES SHALL BE SHOWN IN THE GIRDER SHOP DRAWINGS, ALL COSTS FOR THESE HOLES SHALL BE INCLUDED IN ITEM 612,99.

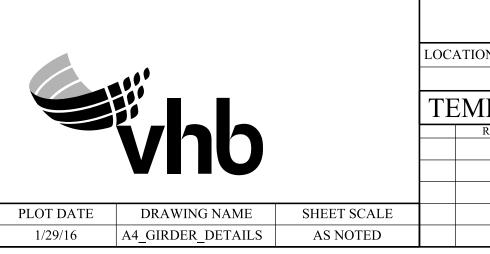

CITY OF DOVER, NEW HAMPSHIRE DEPARTMENT OF COMMUNITY SERVICES

LOCATION WHITTIER STREET OVER COCHECO RIVER BRIDGE NO. 111/132 STATE PROJECT 15402

AP. GAS MAIN BRIDGE - GIRDER DETAILS AND NOTES										
REVISIONS AFTER PROPOSAL			A4 OF 5							
		DESIGNED	JM/DPI) 1/29	CHECKED	TSB	1/29	FILE NUMBER		
		DRAWN	DPI	D 1/29	CHECKED	TSB	1/29			
		QUANTITIES			CHECKED					
		ISSUE DATE			PROJECT NO.	SHE	EET NO.	TOTAL SHEETS		
		REV. DATE		Х-,	A002(794)		A4	5		

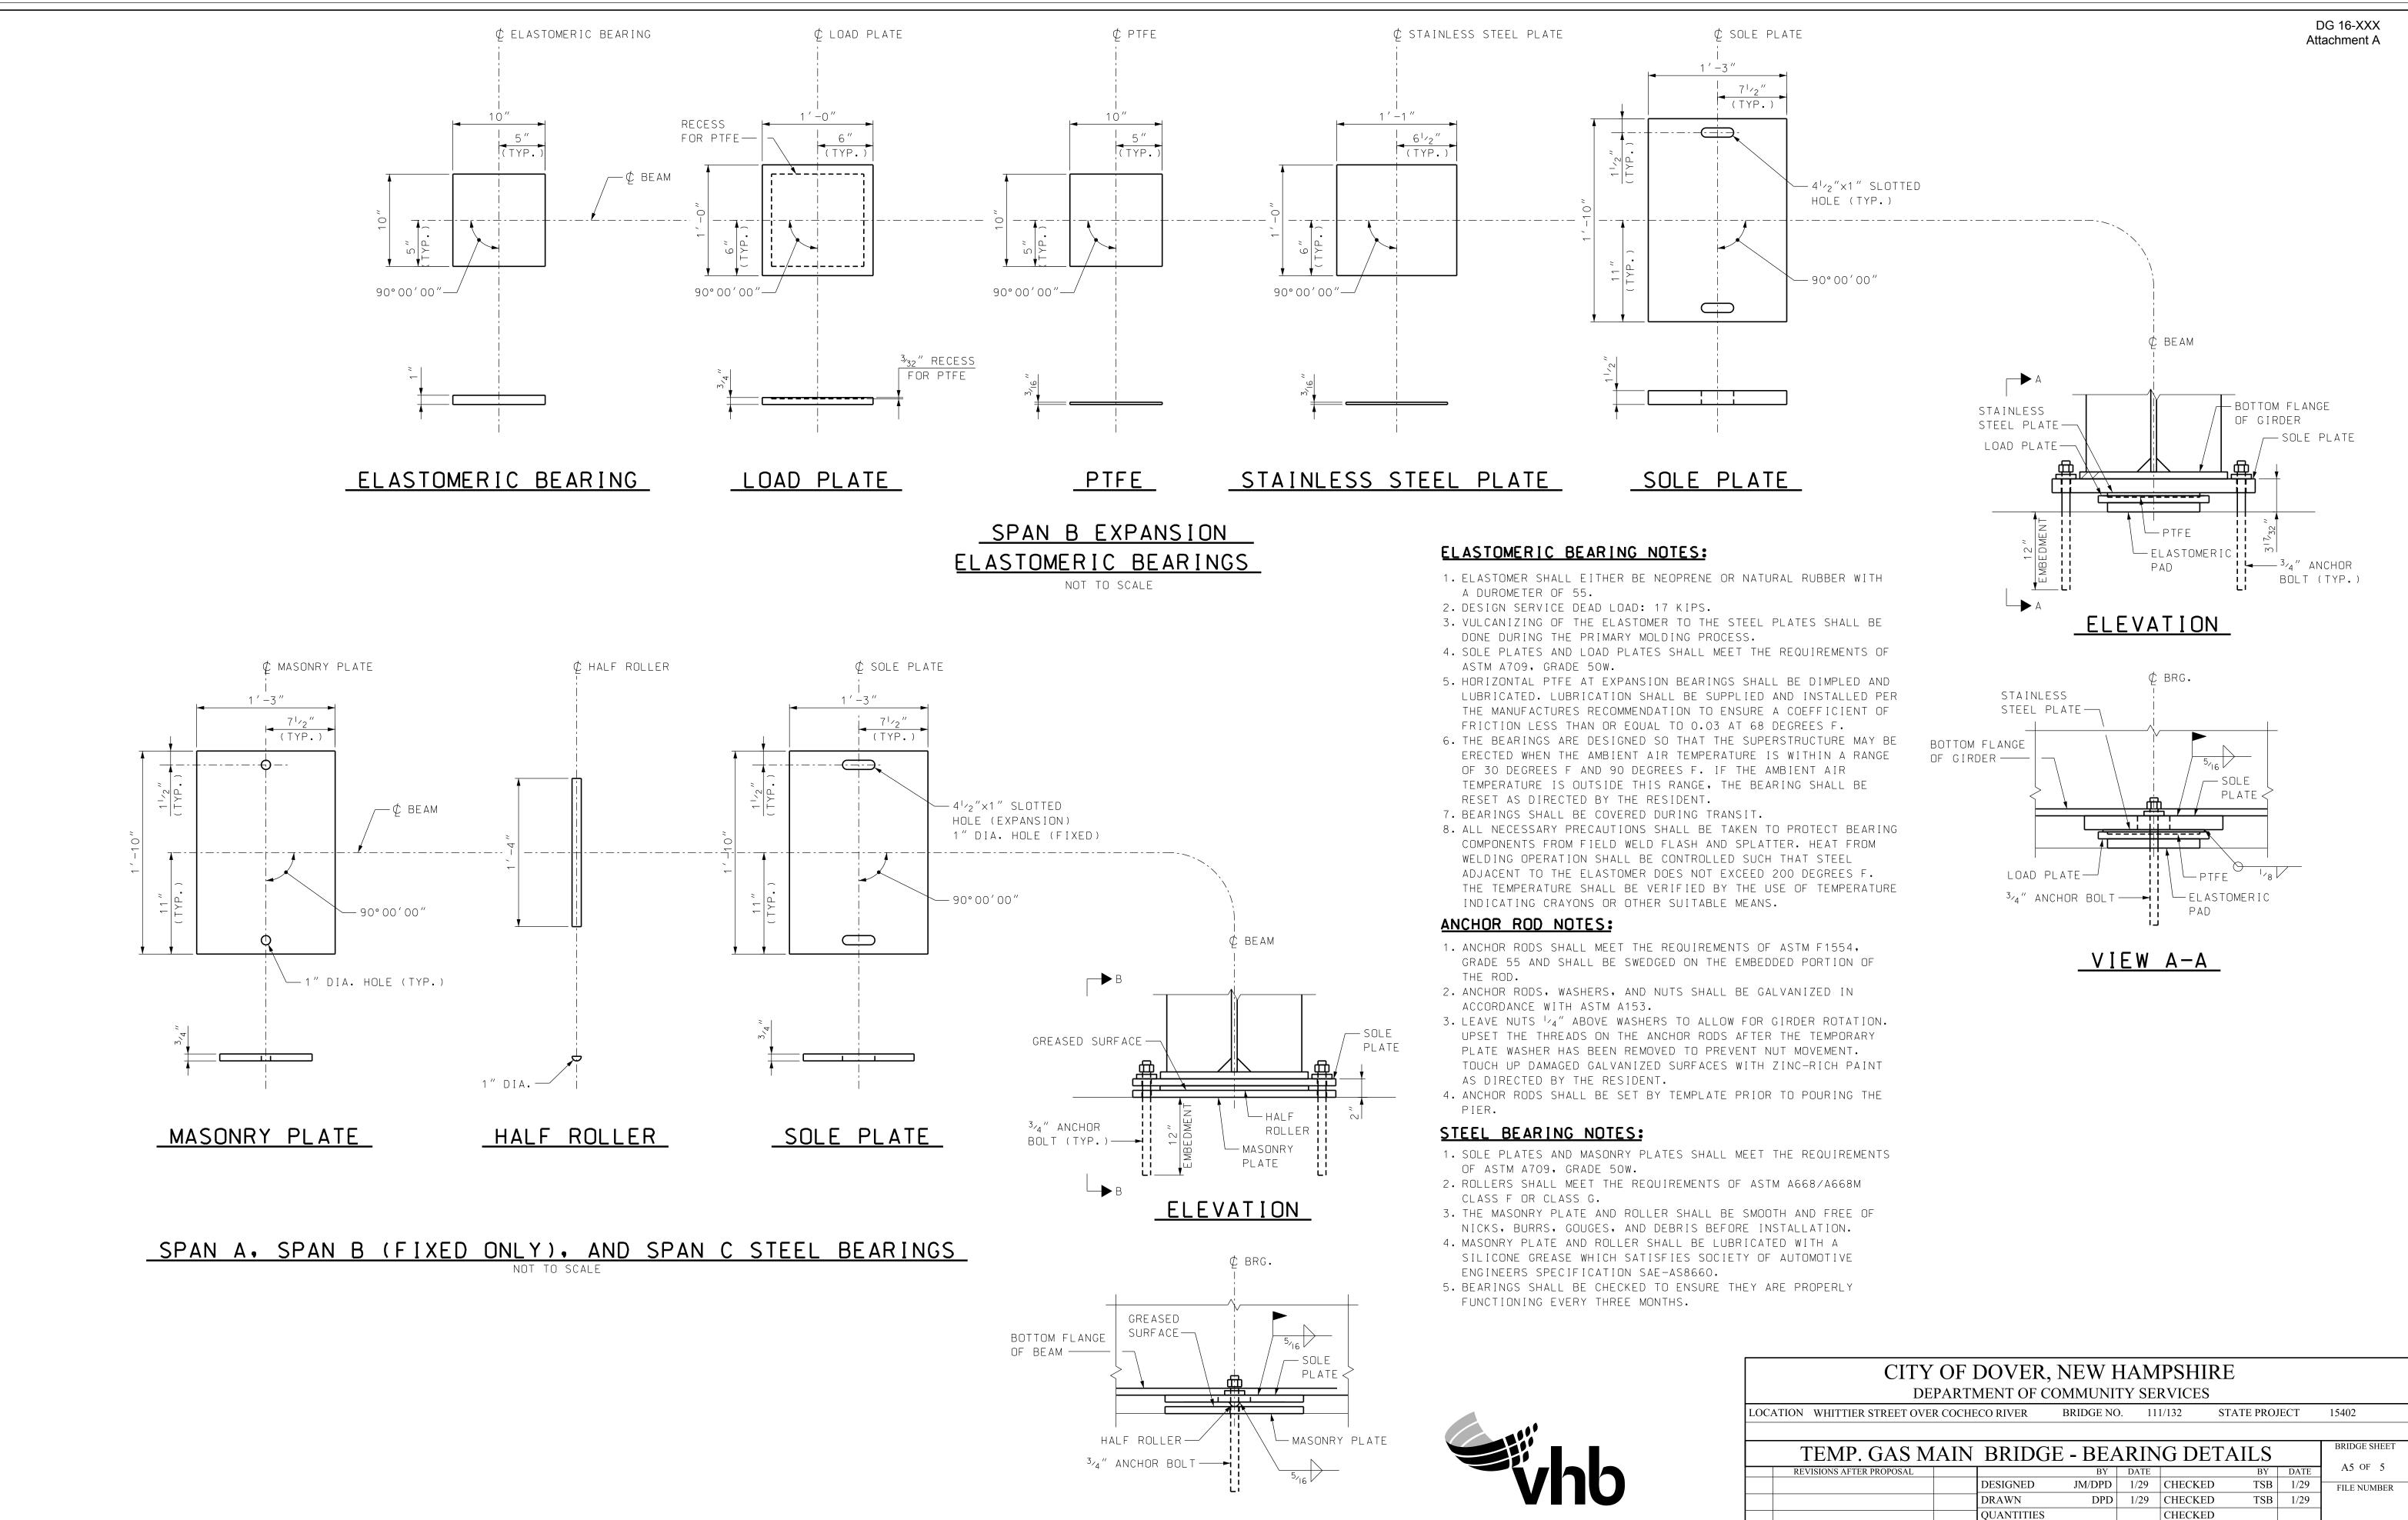

VIEW B-B

SHEET SCALE A5 BEARING DETAILS AS NOTED

DRAWING NAME

PLOT DATE

1/29/16

FEDERAL PROJECT NO.

X-A002(794)

ISSUE DATE

REV. DATE

TOTAL SHEETS

SHEET NO.

A5



Granite State Gas Transmission

WHITTIER STREET BRIDGE


WHITTIER STREET OVER COCHECO RIVER DOVER, NH 03820

		INDEX OF SHEETS	
NUMBER	NAME	TITLE	
1	TO1	COVER SHEET	
2	A01	SITE PLAN	
3	C01	GENERAL DETAILS	
4	C02	BILL OF MATERIALS	
5	CO3	BRIDGE DETAILS	
6	C04	ABUTMENT DETAILS	




1600 Providence Highway Walpole, MA 02081 781.829.0524 processpipelineservices.com

DG 16-XXX Attachment B

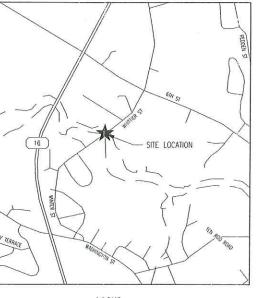

LOCUS SCALE: NTS

ISSUE STATUS	DATE	REVIEWED	CHECKED	APPRO	NED
25% SUBMISSION					
50% SUBMISSION					
75% SUBMISSION					
90% SUBMISSION					
ISSUED FOR BIC					
ISSUED FOR CONSTRUCTION	03/04/16				
AS CONSTRUCTED					_
FILE NAME: 5201_COO.DWG	- (C	1	5/2E	SHEET	REV
PLOT DATE: 03/03/2016 4:48	PM		22X34	T01	
			SHEET 1	OF 6	

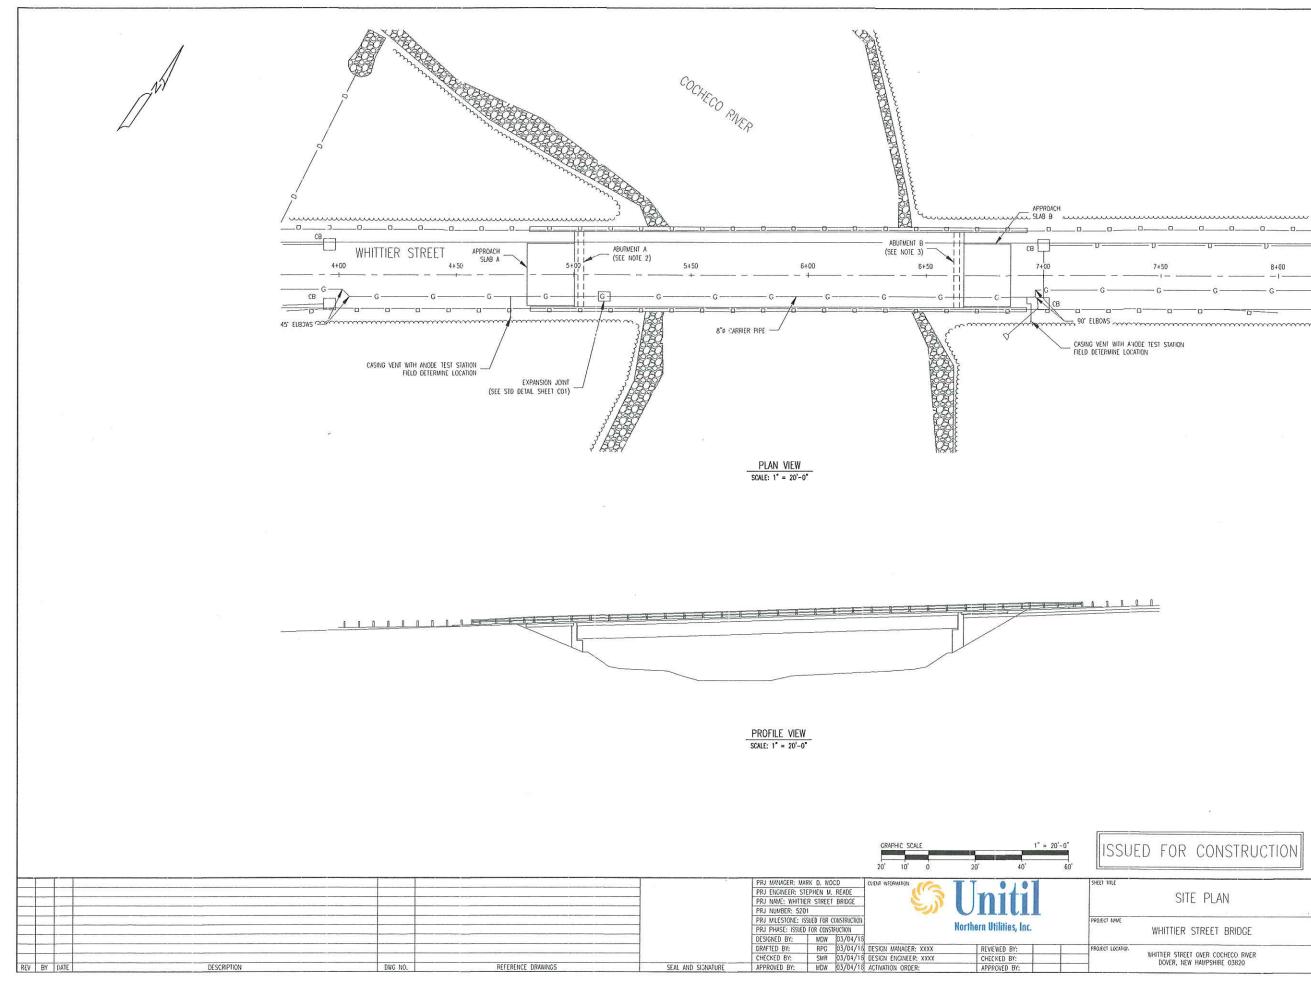


	 FOR FURTHER DETAIL REFER TO PLAN TITLED ABUTMENT B – MASONRY SHEET 20 OF 58. 								
SITE PLAN	PIPELINE D 781.0	1600 Providence Highway Walpole, MA 02081. 781.829.0524 processpipelineservices.com							
TTIER STREET BRIDGE									
	FILE NAME: 5201_COO.DWG	SIZE SHEET REV							
R STREET OVER COCHECO RIVER VER. NEW HAMPSHIRE 03820	PLOT DATE: 03/03/2016 4:48 PM	22X34 A01 G							
TER, RET TIAM STIRE 05620	SCALE: 1" = 20'-0"	SHEET 2 OF 6							

NOTES: 1. THE FOLLOWING REFERENCED DRAWINGS ARE PART OF A LARGER PLAN SET TITLED: CITY OF DOVER, DEPARTMENT OF COMMUNITY SERVICES, CONSTRUCTION PLANS, WHITTER STREET OVER COCHECO RIVER, FEDERAL PROJECT NO. X-AOG(754), N.H.JO.T. PROJECT NO. 15402, FERUARY 2016; ROADWAY PLANS AND BRIDGE PLANS PREPARED BY: THE LOUIS BERGER GROUP. INC., MANCHESTER, NEW HAMPSHIRE, (603) 644 5200.

2. FOR FURTHER DETAIL REFER TO PLAN TITLED ABUTMENT A - MASONRY SHEET 18 OF 58.

8+00

DG 16-XXX Attachment B

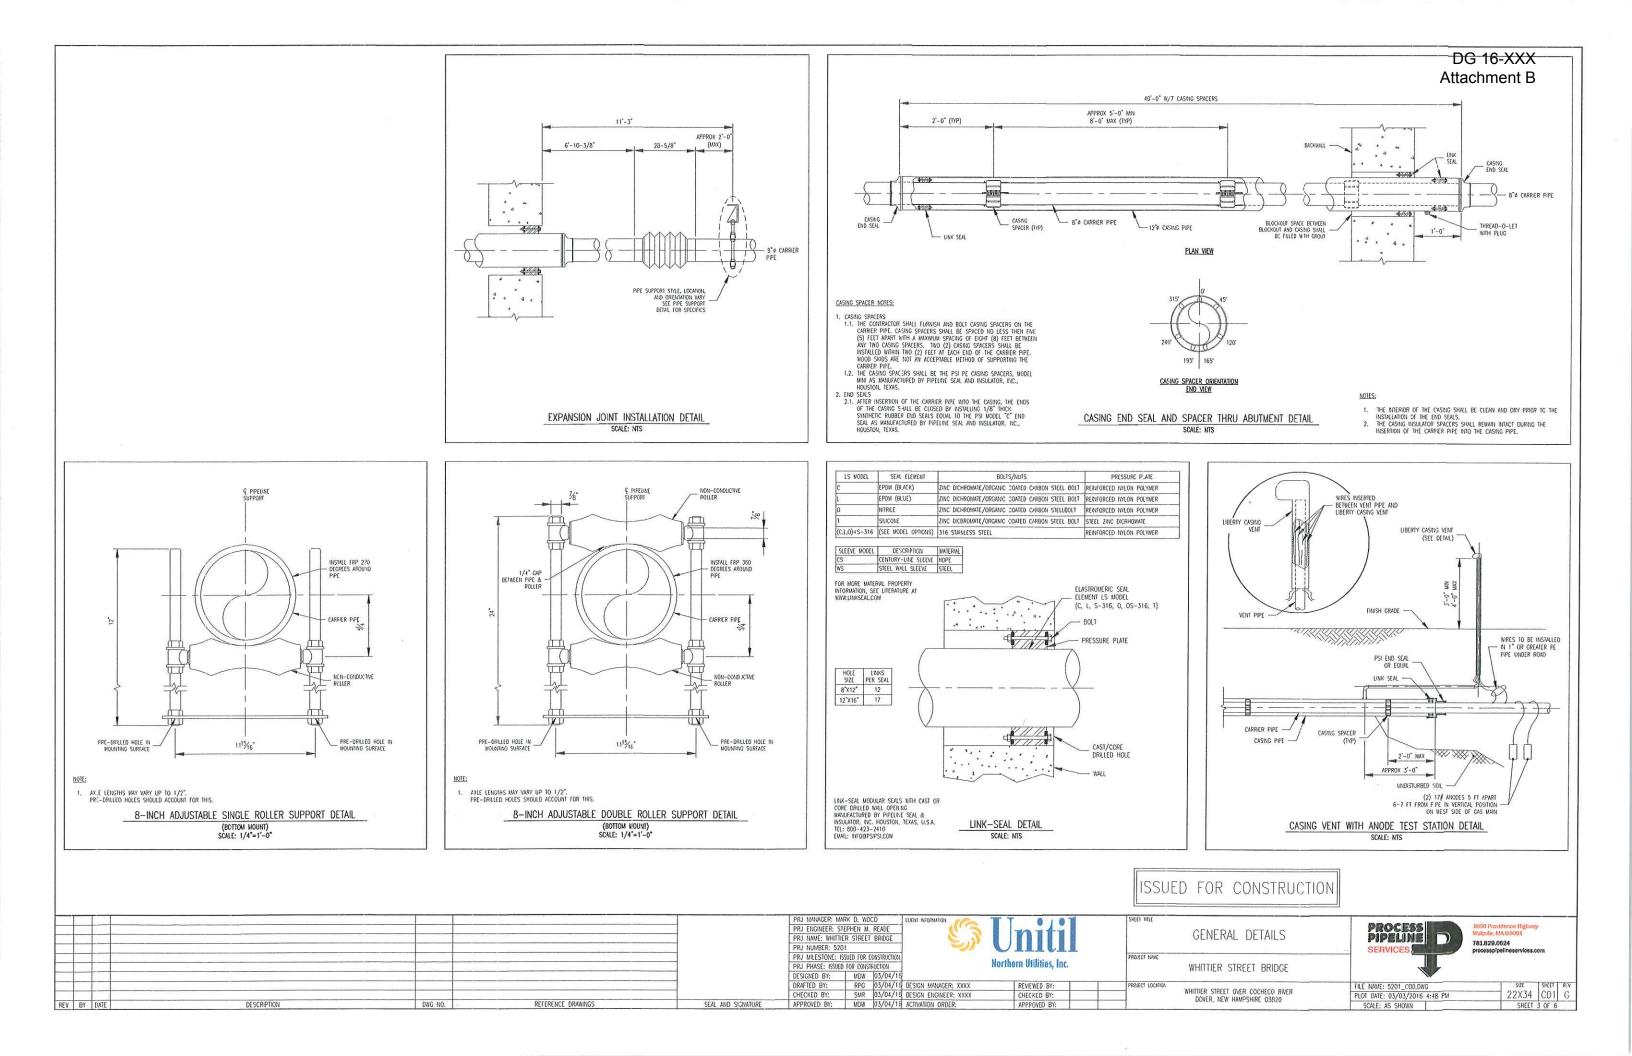



								B	ILL OF MATERIAL	
ITEM	OTY	UOM	SIZE (IN)	DESCRIPTION	RATING	THICKNESS (IN)	STANDARD	MATERIAL SPEC	MANUFACTURER	NOTES
1	300	LF	8	PIPE	SCHD 40	0.322	-	API 5L, GR B	-	PRITEC 1080 COATED - NISOURCE GAS TRANSMISSION AND STORAGE SPECIFICATION OEP-1
2	80	LF	12	PIPE	SCHD 40	0.375	-	API 5L, GR B	-	PRITEC 1080 COATED - NISOURCE GAS TRANSMISSION AND STORAGE SPECIFICATION DEP-1
3	40	LF	2	PIPE	SCHD 40	0.154	-	API 5L, GR B	-	PRITEC 1080 COATED - NISOURCE GAS TRANSMISSION AND STORAGE SPECIFICATION DEP-
4	15	LF	2	PIPE	SCHD 40	0.154	=	API 5L, GR B	-	BARE, SEAMLESS
5	8	EA	2	ELB, 90 DEG, LR	-	0.154	ASME B16.9	ASTM A-234, WPB	7	-
6	2	EA	12 x 2	WELD-O-LET	3000 LB	÷	ASME B16.11	ASTM A-105	-	
7	8	EA	8	ADJUSTABLE DOUBLE ROLLER GUIDE SUPPORT		7	-	-	LB&A, Inc	MODEL : 38 ASSEMBLY, WITH MODEL 6H NON-CODUCTIVE ROLLER(S) AND 304SS SLEEVE(S
8	14	EA	8 X 12	CASING SPACER		-	-	-	PSI, Inc	MODEL : PE, RUNNER HEIGHT 1.0", BAND WIDTH 5.0"
Ģ	4	EA	8 X 12	END SEAL	-	-	-	-	PSI, Inc	MODEL : C
10	4	EA	LS-475-S-316-12	LINK SEAL	-	a a c	-	-	PSI, Inc	COMPLETE ASSEMBLY (OTY 12 LINKS PER SEAL)
1	2	EA	2	PLUG, HEX HEAD, MNPT	-	-	ASME B16.11	ASTM A-105	-	-
12	7	EA	8	ADJUSTABLE SINGLE ROLLER GUIDE SUPPORT	-	-	-	-	LB&A, Inc	MODEL : 28 ASSEMBLY, WITH MODEL 6H NON-COCUCTIVE ROLLER(S) AND 304SS SLEEVE(S
13	2	EA	3.5 X 72	CASING VENT	-	-	-	-	LIBERTY	P/N: LCV - YELLOW
14	2	EA	12 x 2	THREAD-O-LET, FW X FNPT	3000 LB	-	ASME B16.11	ASTM A-105	-	-
15	16	EA	FRP TYPE 180	SADDLES 9" LONG X 1/8" THICK	-	-	-	-	GLAS MESH CO. INC.	-
16	1	EA	8-7HF-WI	EXPANSION JOINT, WE X WE	-	0.322	-	-	BADGER INDUSTRIES	JB-008007-H1036
17	2	EA	LS-475-S-316-17	LINK SEAL	3 	-	-	-	PSI, Inc	COMPLETE ASSEMBLY (OTY 17 LINKS PER SEAL)
18	7	EA	FRP TYPE 270	SADDLES 9" LONG X 1/8" THICK	-	-	-	-	GLAS MESH CO. INC.	-
19	2	EA	8	ELB, 90 DEG, LR	-	0.322	ASME B16.9	ASTM A-234, WPB	-	-
20	2	EA	8	ELB, 45 DEG, LR	-	0.322	ASME B16.9	ASTM A-234, WPB	-	-


								ISSU	ED FOR CONSTRUCTION		
					PRJ MANAGER; MARK D. WOCD PRJ ENGINEER: STEPHEN M. READE PRJ NAME: WHITTIER STREET BRIDGE PRJ NUMBER: 5201	CLIENT INFORMATION	Unitil	SHEET THLE	BILL OF MATERIALS	PROCESS PIPELINE SERVICES	1800 Providence Highway Walpole, MA 02081 761.829.0524 process/polineervices.com
					PRJ MILESTONE: ISSUED FOR CONSTRUCT PRJ PHASE: ISSUED FOR CONSTRUCTION DESIGNED BY: MDW 03/04,	16	Northern Utilities, Inc.	PROJECT NAME	WHITTIER STREET BRIDGE	T T	
					DRAFTED BY: RPG 03/04,	16 DESIGN MANAGER: XXXX	REVIEWED BY:	PROJECT LOCATION		FILE NAME: 5201_COO.DWG	SIZE SHEET REV
						15 DESIGN ENGINEER: XXXX	CHECKED BY:		WHITTIER STREET OVER COCHECO RIVER DOVER, NEW HAMPSHIRE 03820	PLOT DATE: 03/03/2016 4:49 PM	22X34 C02 G
REV BY DATE	DESCRIPTION	DWG NO.	REFERENCE DRAWINGS	SEAL AND SIGNATURE	APPROVED BY: MDW 03/04/	16 ACTIVATION ORDER:	APPROVED BY:		boren, new man shake 00020	SCALE: N/A	SHEET 4 OF 6

DG 16-XXX Attachment B

	 104220	
	 Sector 1	

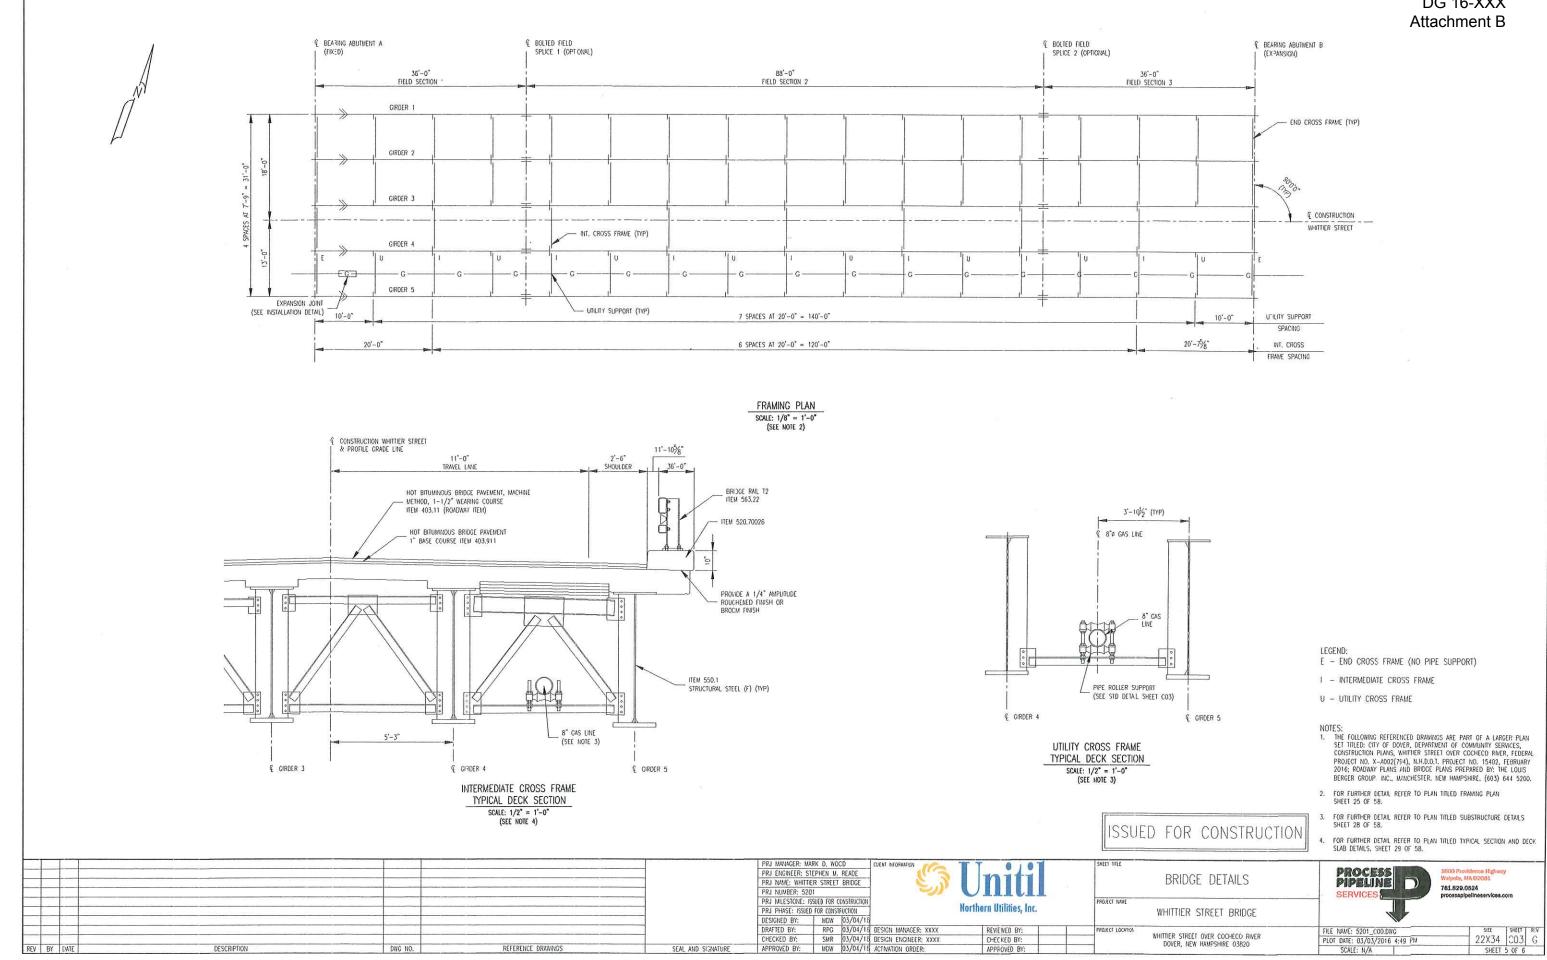

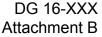

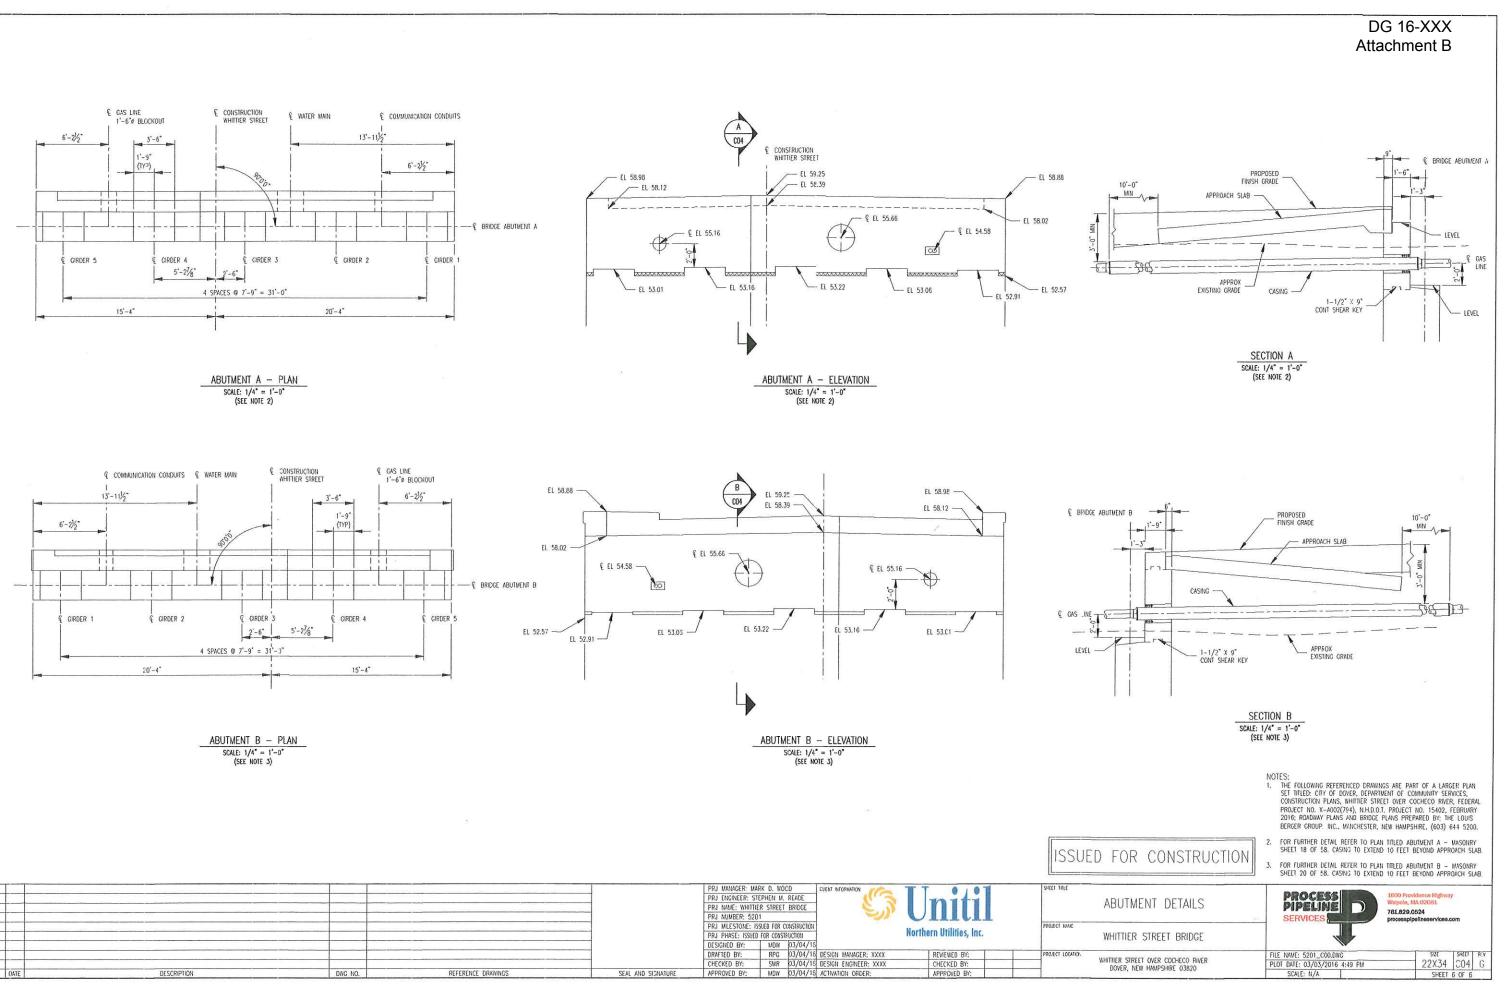

							PRJ MANAGER: N			CUENT INFORMATION	TT OIOT	SHEET TALE	
							PRJ ENGINEER: S	STEPHEN M.	READE	0.5	10 1 1 1		ABUTM
								TIER STREET	BRIDGE	C. 3			ADUIN
							PRJ NUMBER: 52	201					
							PRJ MILESTONE:	ISSUED FOR (CONSTRUCTION	4	Handland Hatlation Inc.	PROJECT NAME	
							PRJ PHASE: ISSU	ED FOR CONST	FUCTION	1	Northern Utilines, Inc.		WHITTIEF
							DESIGNED BY:	MDW	03/04/1	6			
							DRAFTED BY:	RPG	03/04/1	6 DESIGN MANAGER: XXXX	REVIEWED BY:	PROJECT LOCATION	
							CHECKED BY:	SMR	03/04/1	S DESIGN ENGINEER: XXXX	CHECKED BY:		WHITTIER STR DOVER, N
REV	BY	DATE	DESCRIPTION	DWG NO.	REFERENCE DRAWINGS	SEAL AND SIGNATURE	APPROVED BY:	MDW	03/04/1	5 ACTIVATION ORDER:	APPROVED BY:		DOVER, N